



**U.S. Army Corps
of Engineers**
Baltimore District

Public Notice

In Reply to Application Number
CENAB-OP-RMS(HICKEY RUN, USNA)
NAB-2007-119-M15

PN07-15

Comment Period: February 12, 2007 to March 6, 2007

THE PURPOSE OF THIS PUBLIC NOTICE IS TO SOLICIT COMMENTS FROM THE PUBLIC ABOUT THE WORK DESCRIBED BELOW. AT THIS TIME, NO DECISION HAS BEEN MADE AS TO WHETHER OR NOT A PERMIT WILL BE ISSUED.

The Baltimore District has received an application for a Department of the Army Permit pursuant to Section 404 of the Clean Water Act (33 U.S.C. 1344), as described below:

APPLICANT: U.S. National Arboretum
ATTN: Dr. Thomas S. Elias
3501 New York Avenue, NE, Room 104A
Washington, DC 20002-1958

LOCATION: In Hickey Run, Washington, District of Columbia.

WORK: The U.S. National Arboretum has entered into a Memorandum of Agreement with the District of Columbia Department of Health and Water and Sewer Authority to construct a stormwater management retrofit on Hickey Run. The proposed project will permanently impact approximately 90 linear feet of stream and consisting of a bypass weir structure that will divert surface floatables, oil and grease to a manufactured treatment facility (e.g. a CDS unit or Baysaver unit). All work is to be completed in accordance with the enclosed plan(s). If you have any questions concerning this matter, please contact Mr. Jack Dinne at (410) 962-6005.

The decision whether to issue a permit will be based on an evaluation of the probable impact including cumulative impacts of the proposed activity on the public interest. That decision will reflect the national concern for both protection and utilization of important resources. The benefit which reasonably may be expected to accrue from the proposal must be balanced against its reasonably foreseeable detriments. All factors which may be relevant to the proposal will be considered including the cumulative effects thereof; among those are conservation, economics, aesthetics, general environmental concerns, wetlands, cultural values, fish and wildlife values, flood hazards, flood plain values, land use, navigation, shoreline erosion and accretion, recreation, water supply and conservation, water quality, energy needs, safety, food and fiber production, and, in general, the needs and welfare of the people.

The Corps of Engineers is soliciting comments from the public; Federal, State, and local agencies and officials; Indian Tribes; and other interested parties in order to consider and evaluate the impacts of this proposed activity. Any comments received will be considered by the Corps of Engineers to determine whether to issue, modify, condition or deny a permit for this proposal. To make this decision, comments are used to assess impacts on endangered species, historic properties, water quality, general environmental effects, and the other public interest factors listed above.

Comments are used in the preparation of an Environmental Assessment and/or an Environmental Impact Statement pursuant to the National Environmental Policy Act. Comments are also used to determine the need for a public hearing and to determine the overall public interest of the proposed activity.

The applicant is required to obtain a water quality certification in accordance with Section 401 of the Clean Water Act from the District of Columbia Department of the Environment. Any written comments concerning the work described above which relate to water quality certification must be received by the Water Quality Division, District of Columbia Department of the Environment, 51 N Street, NE, 5th Floor, Washington, DC 20002 within the comment period as specified above to receive consideration. Written comments concerning the work described above related to the factors listed above or other pertinent factors must be received by the District Engineer, US Army Corps of Engineers, Baltimore District, PO Box 1715, Baltimore, Maryland 21230-1715, within the comment period as specified above to receive consideration. The 401 certifying agency has a statutory limit of one year to make its decision.

The applicant must obtain any State or local government permits which may be required.

A preliminary review of this application indicates that the proposed work will not affect listed species or their critical habitat pursuant to Section 7 of the Endangered Species Act as amended. As the evaluation of this application continues, additional information may become available which could modify this preliminary determination.

Review of the latest published version of the National Register of Historic Places indicates that no registered properties listed as eligible for inclusion therein are located at the site of the proposed work. Currently unknown archeological, scientific, prehistoric, or historical data may be lost or destroyed by the work to be accomplished under the requested permit.

The evaluation of the impact of the work described above on the public interest will include application of the guidelines promulgated by the Administrator, U.S. Environmental Protection Agency, under authority of Section 404 of the Clean Water Act. Any person who has an interest which may be adversely affected by the issuance of this permit may request a public hearing. The request, which must be in writing, must be received by the District Engineer, US Army Corps of Engineers, Baltimore District, PO Box 1715, Baltimore, Maryland 21203-1715, within the comment period as specified as above to receive consideration. Also, it must clearly state forth the interest which may be adversely affected by this activity in the manner in which the interest may be adversely affected.

It is requested that you communicated the foregoing information concerning the proposed work to any persons known by you to be interested and not being known to this office, who did not receive a copy of this notice.

FOR THE DISTRICT ENGINEER:



PAUL R. WETTLAUFER
Acting Chief, Maryland Section Southern

HICKEY RUN STORMWATER POLLUTION ABATEMENT PROJECT

PHASE I

CONCEPTUAL DESIGN

WASHINGTON, DC

DECEMBER 2005

INDEX


DWG	TITLE
1	COVER AND INDEX
2	EXISTING SITE PLAN
3	PROPOSED ACCESS ROAD AND DETAILS
4	COS SITE PLAN
5	COS PLAN AND SECTIONS
6	COS SECTIONS AND DETAILS
7	BANSWER SITE PLAN
8	BANSWER PLAN AND SECTIONS
9	BANSWER SECTIONS AND DETAILS
10	BYPASS WEIR PLAN AND SECTIONS
11	CONSTRUCTION SEQUENCING



LOCATION MAP
NO SCALE

LEGEND

- E DGE OF ROAD
- EXISTING UTILITY POLE
- EXISTING LIGHTPOLE
- MANHOLE
- EXISTING SANITARY SEWER
- EXISTING WATER MAIN
- EXISTING STORM DRAIN
- EXISTING CONTOUR MINOR
- EXISTING CONTOUR MAJOR
- EXISTING CHAIN LINK FENCE
- EXISTING PERIMETER FENCE
- EXISTING TREE
- EXISTING EDGE OF WOODS
- EXISTING BUILDINGS
- EXISTING SIGN

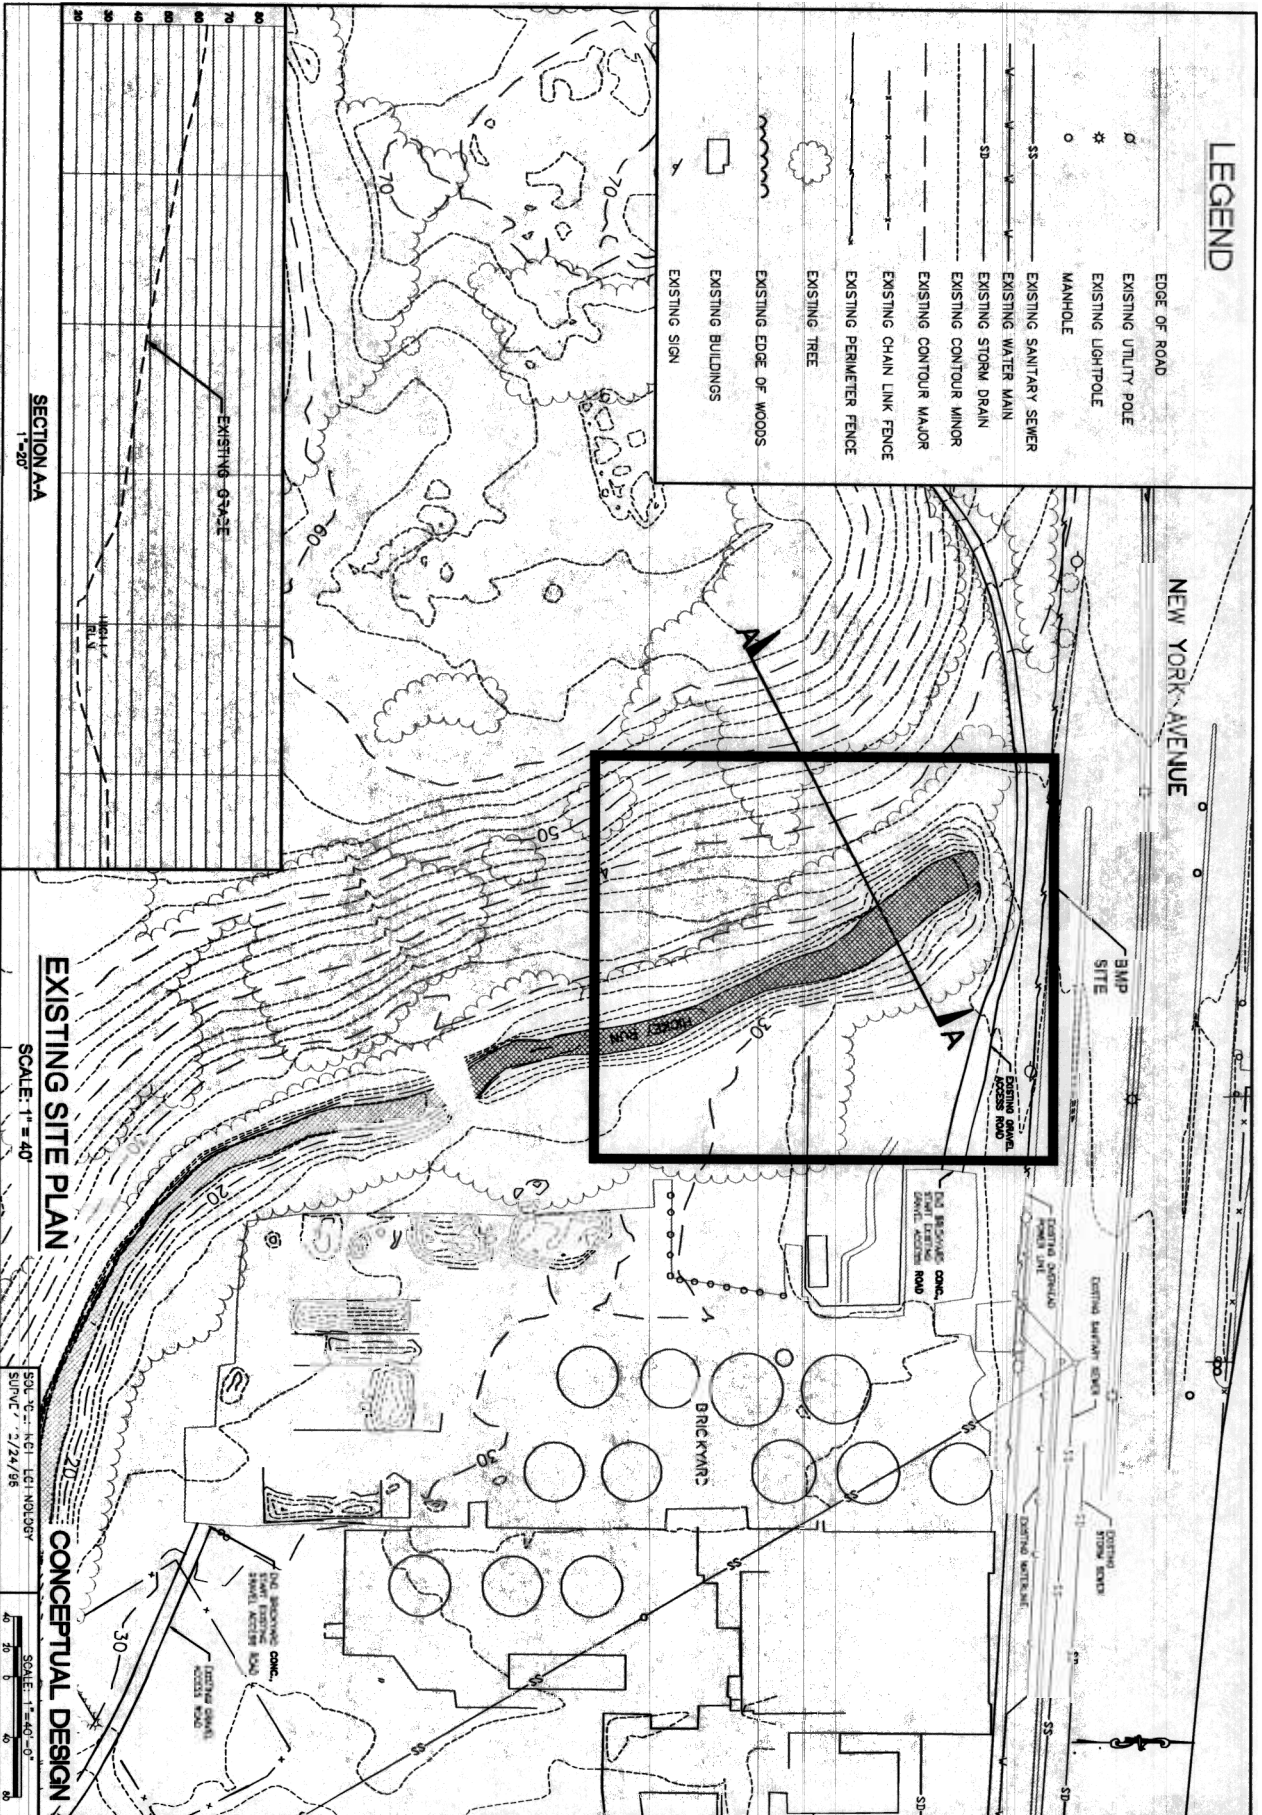

EarthTech
A Tyco International Ltd. Company

875 N WASHINGTON STREET, SUITE 300
ALPHARETTA, GEORGIA 30004
(770) 546-6728

DEPARTMENT OF THE ARMY
NAVAL FACILITIES ENGINEERING COMMAND
PHASE I
HICKEY RUN STORWATER
POLLUTION ABATEMENT PROJECT
EXISTING SITE PLAN


WASHINGTON D.C. 20300

NO.	DESCRIPTION	PREPARED BY	DATE	APPROVED BY

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SHEET NO. 2 OF 11

CONCEPTUAL DESIGN
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EXISTING SITE PLAN
SCALE: 1"=40'-0"

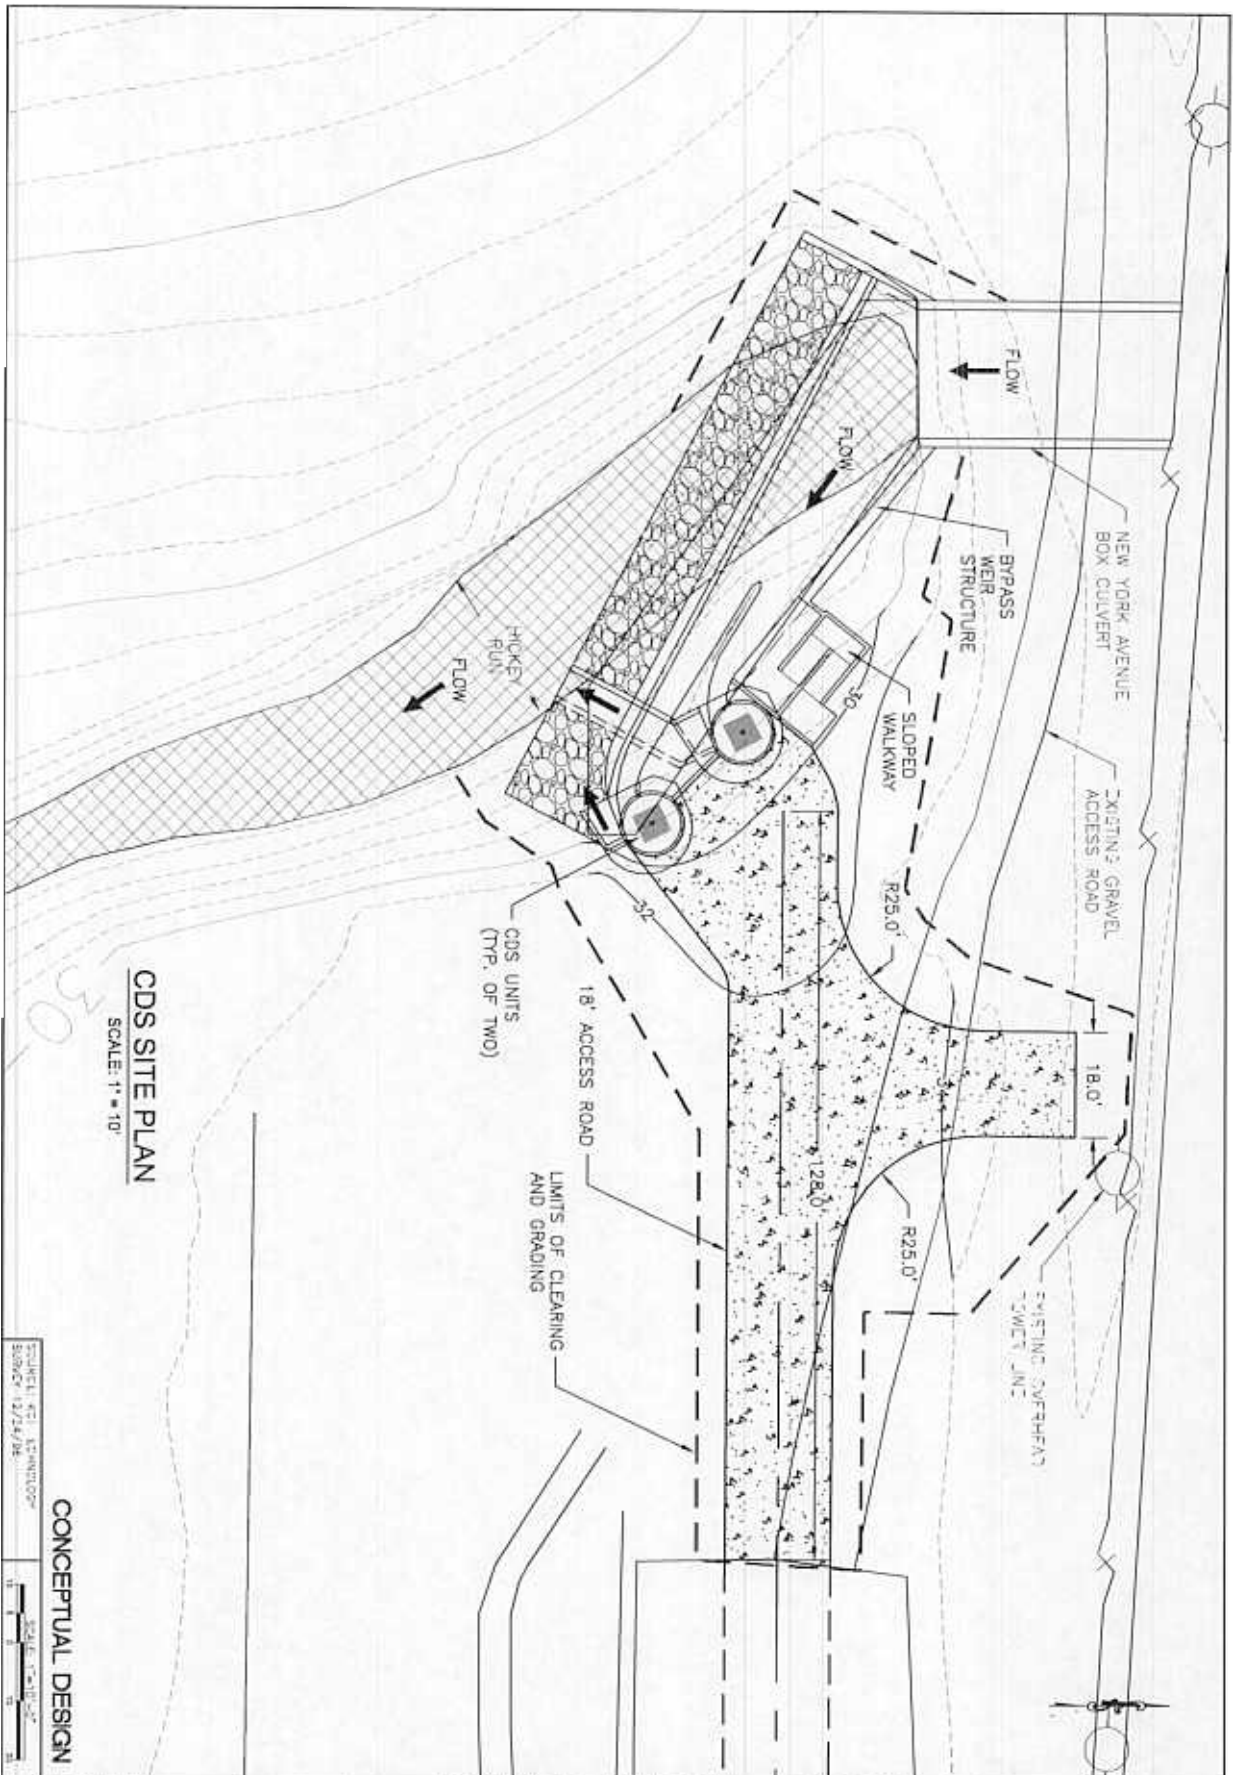


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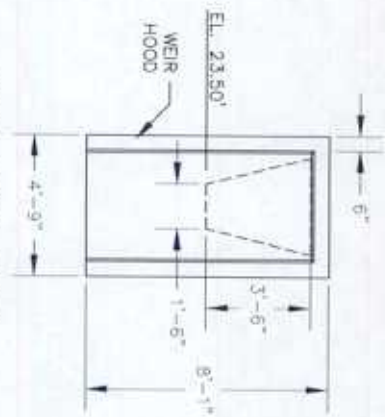
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DATE: 12/14/06

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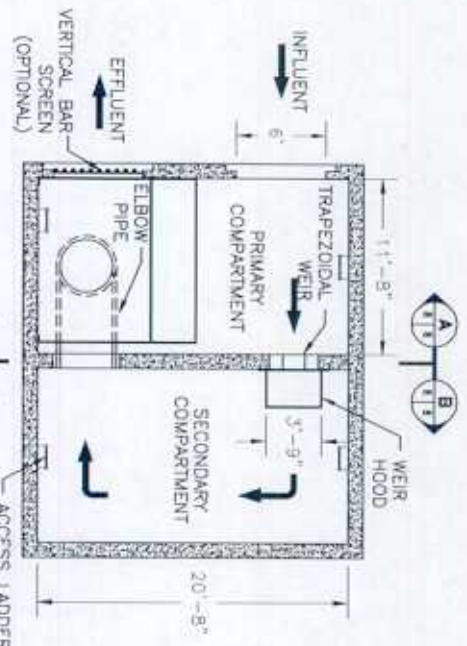
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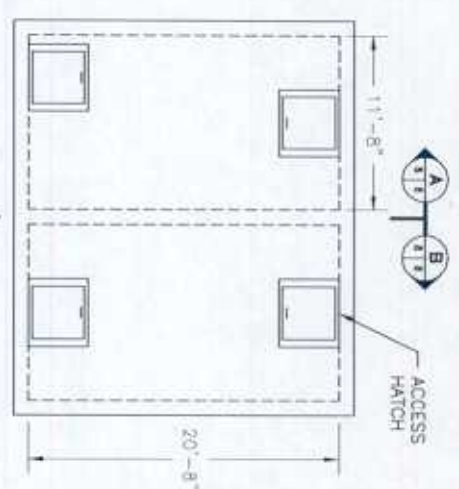
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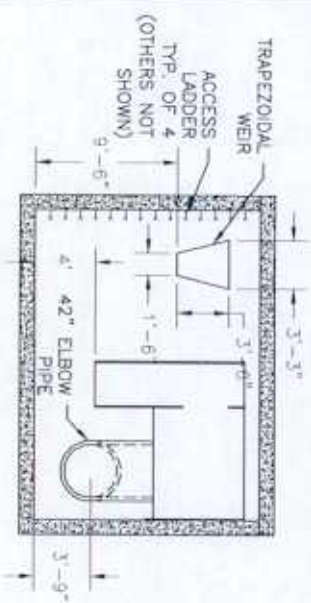
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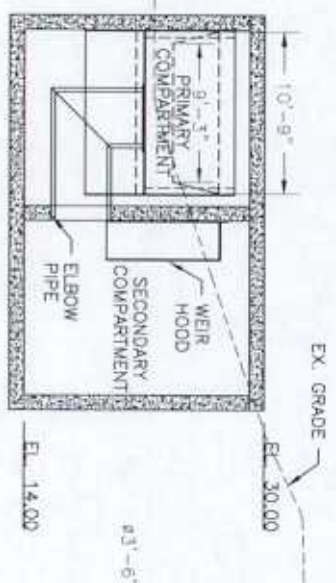
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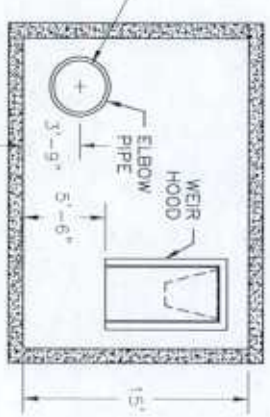
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SECTION A-A
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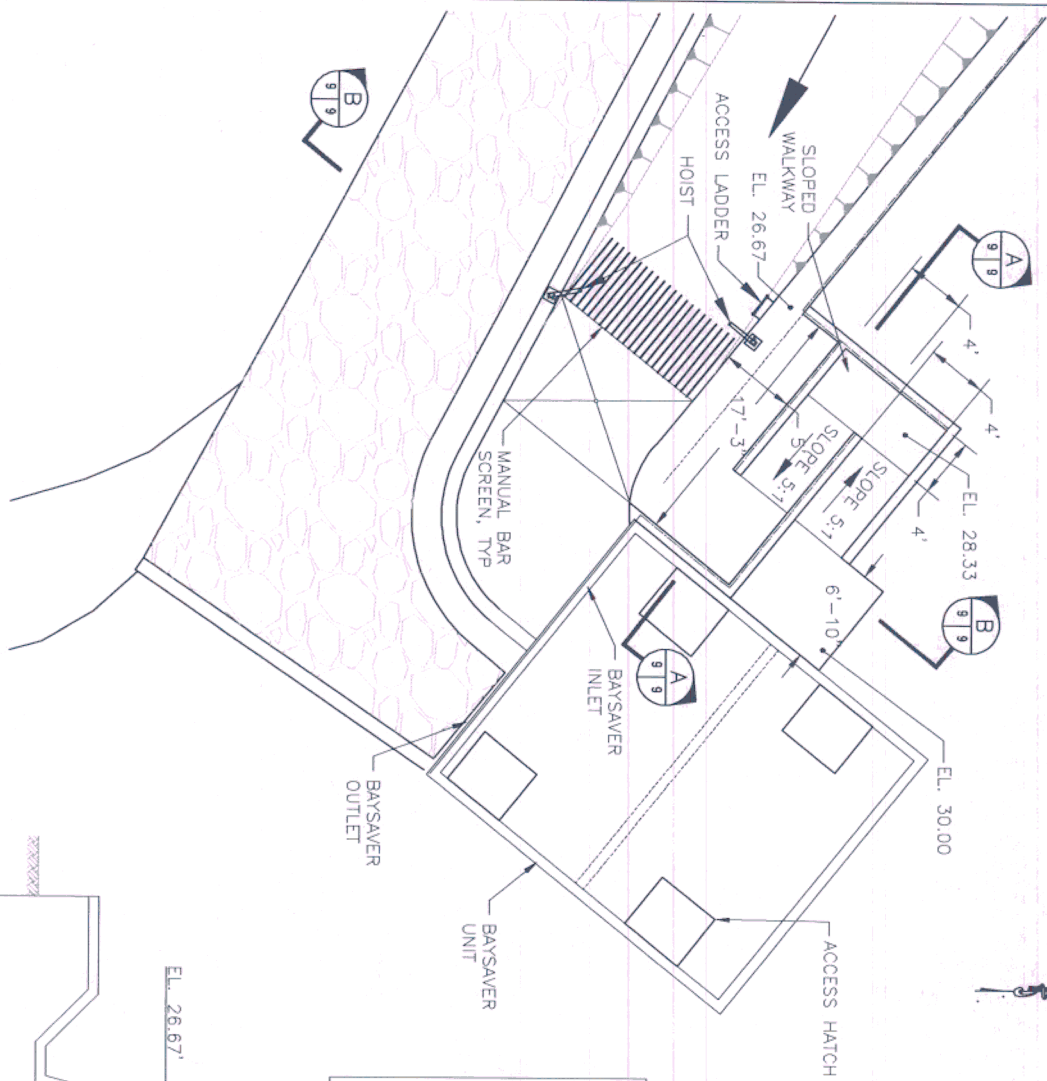


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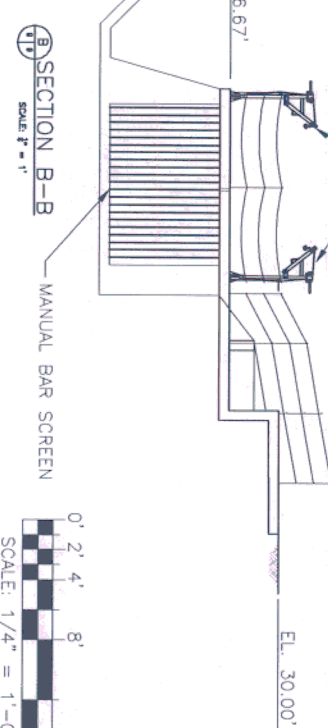
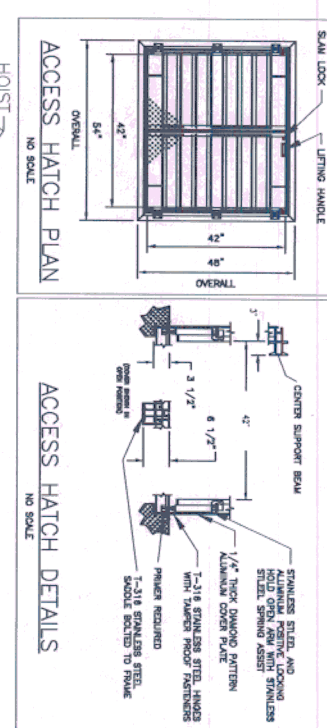
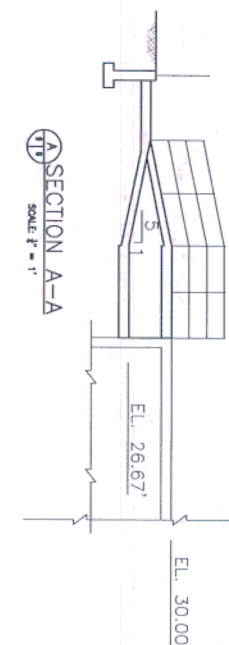


SECTION B-B
SCALE: 1/2" = 1'

CONCEPTUAL DESIGN

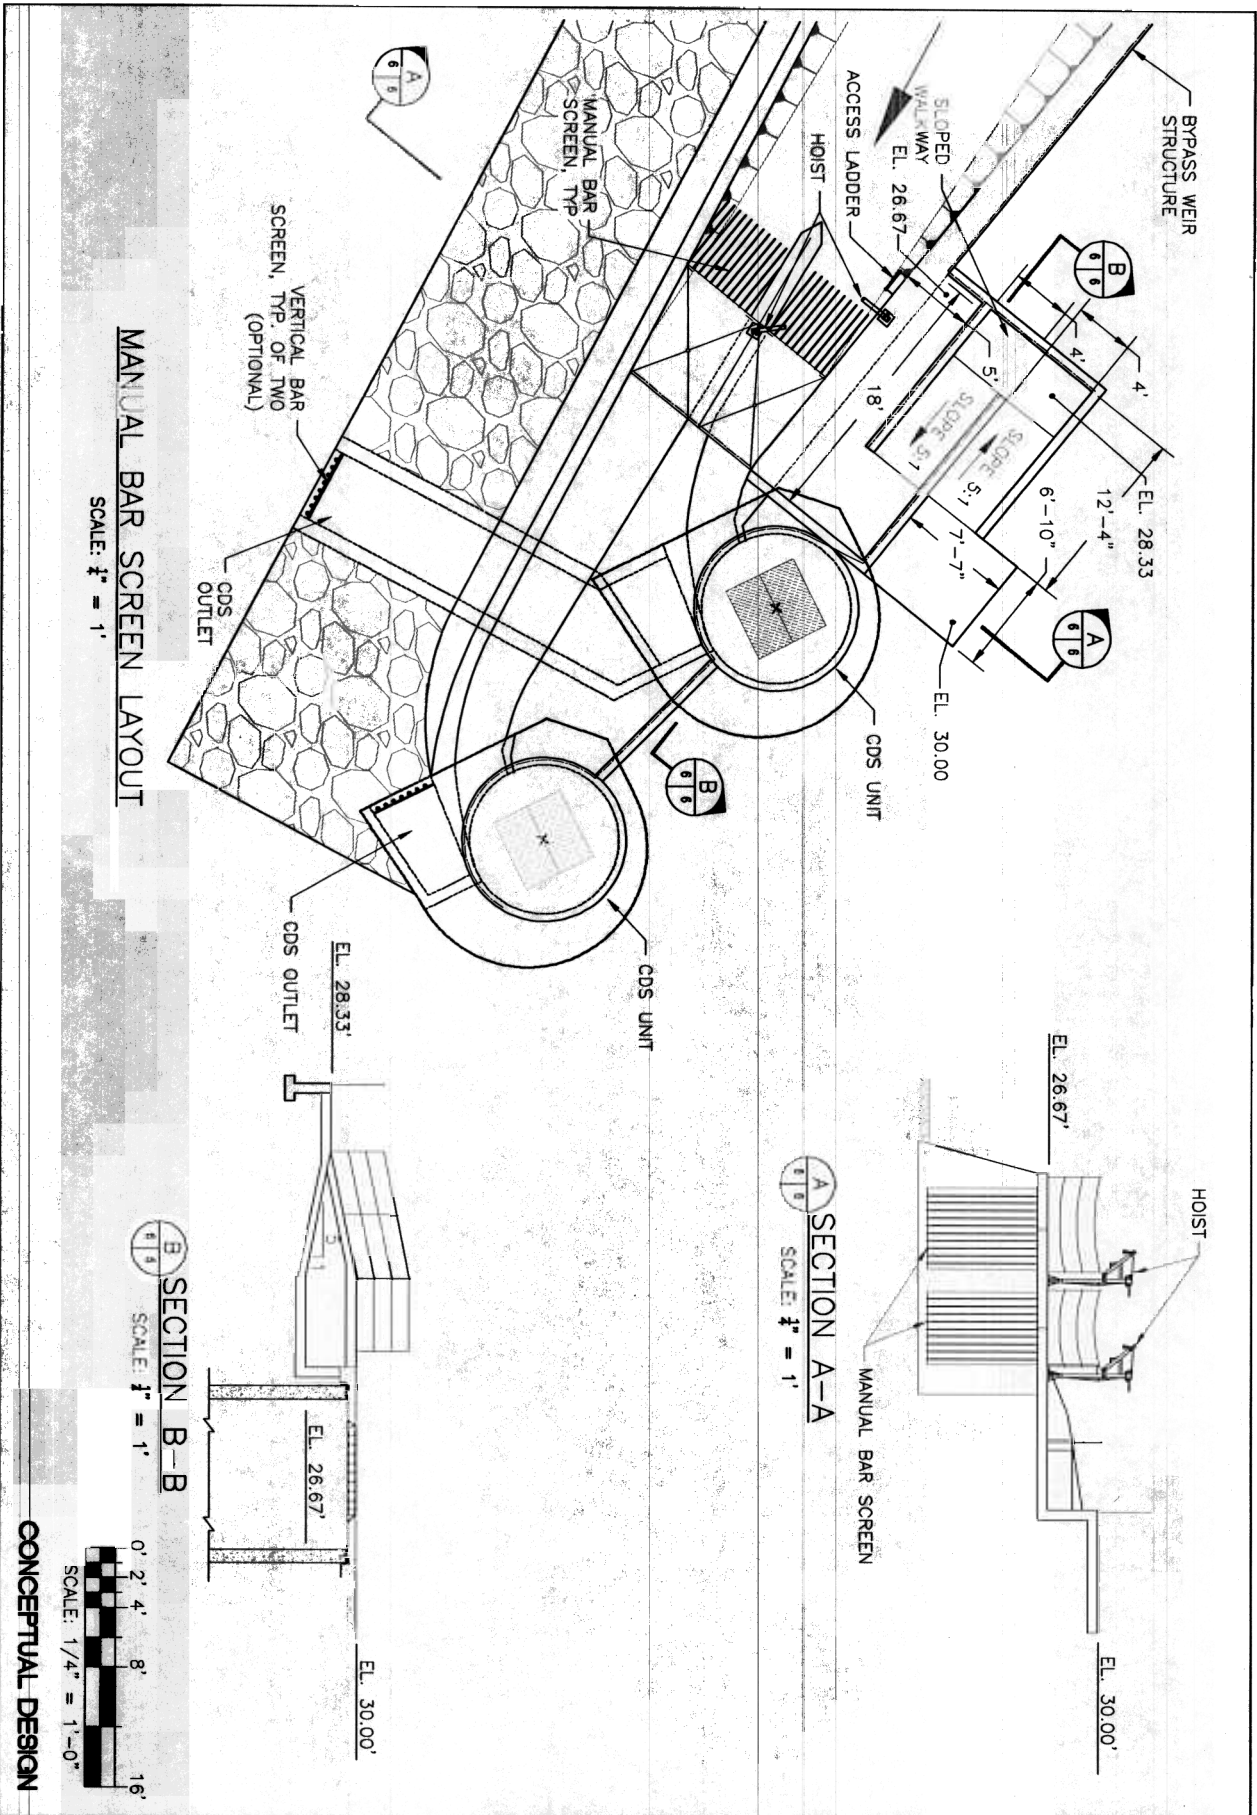

MANUAL BAR SCREEN LAYOUT
SCALE: 1" = 1'



0' 2' 4' 8' 16'
SCALE: 1/4" = 1'-0"

CONCEPTUAL DESIGN

EarthTech
A tyco International Ltd. Company
675 N WASHINGTON STREET, SUITE 300
ALEXANDRIA, VIRGINIA 22314
(703) 549-8728

PROJECT NO.	10000000000000000000
DATE	10/10/2000
BY	10/10/2000
CHECKED BY	10/10/2000
APPROVED BY	10/10/2000


DEPARTMENT OF THE NAVY
NAVAL FACILITIES ENGINEERING COMMAND
PHASE I
HICKEY RUN STORWATER
POLLUTION ABATEMENT PROJECT
BAYSAYER SECTIONS AND DETAILS

NO.	DESCRIPTION	PREPARED BY	DATE	APPROVED BY
1	REVISIONS			


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CONTRACT NO.
INSTRUMENT NO.
SPEC. NO.
NAVFAC DRAWING NO.
SHEET 9 OF 11



BYPASS WEIR PLAN
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A SECTION
SCALE: 1/4" = 1'-0"

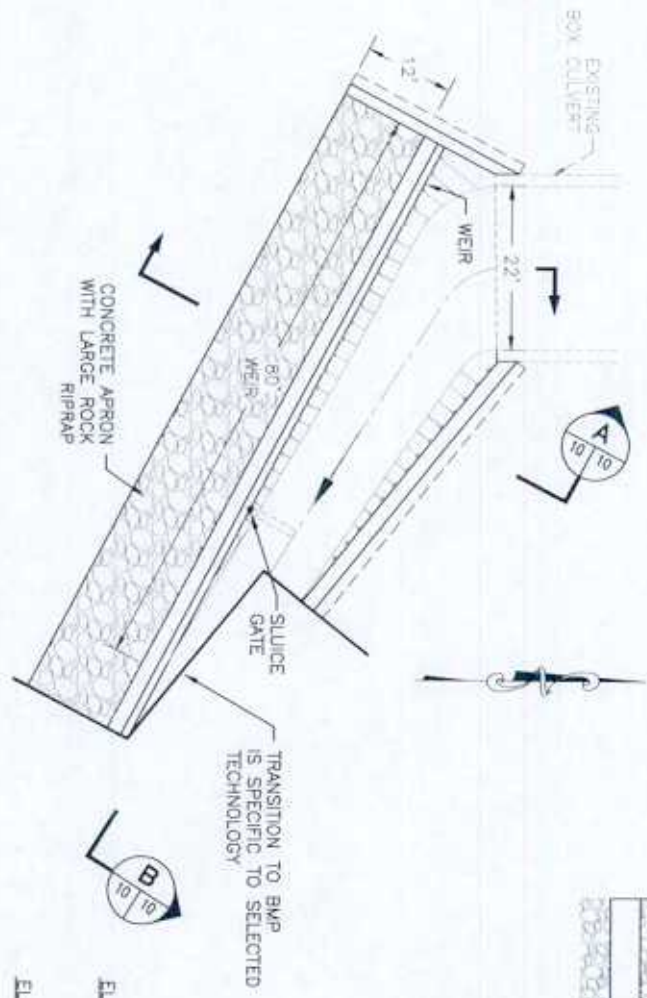





B SECTION
SCALE: 1/8" = 1'-0"

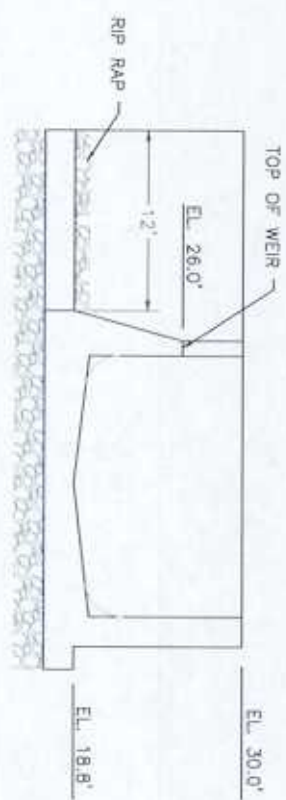

CONCEPTUAL DESIGN

8

SCALE 1"=10'-0"

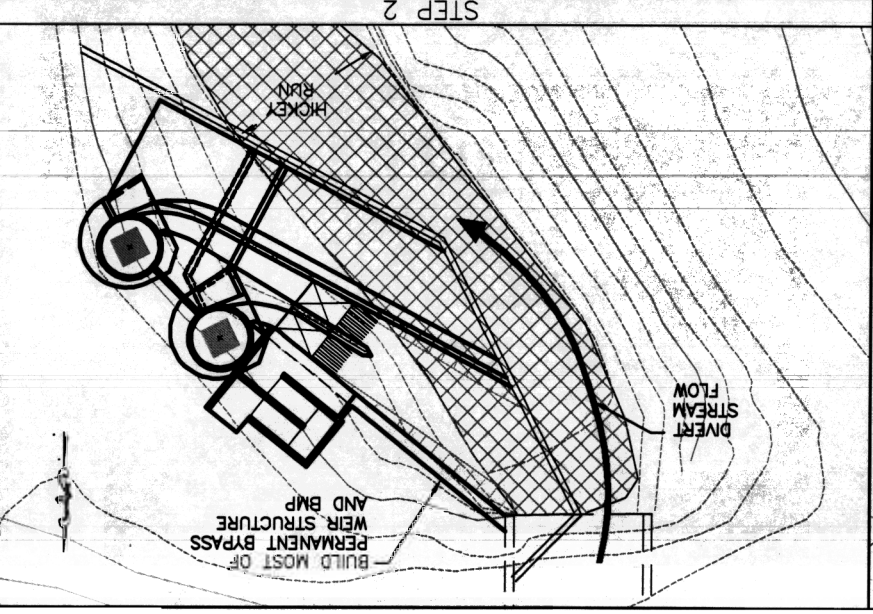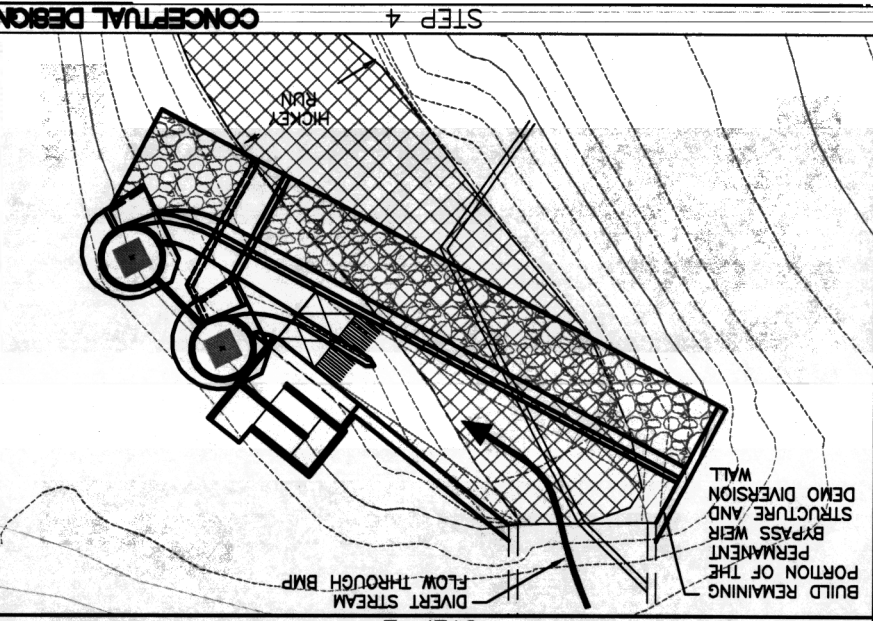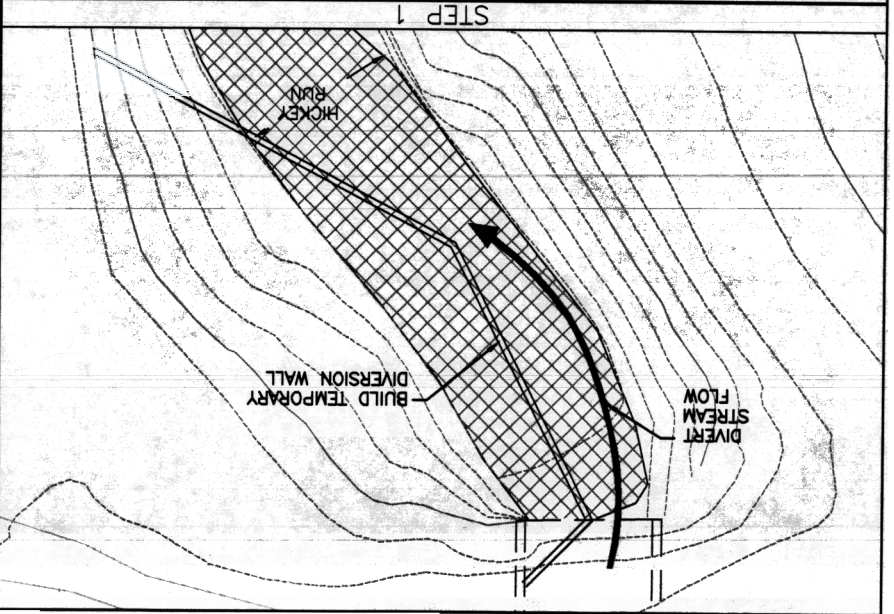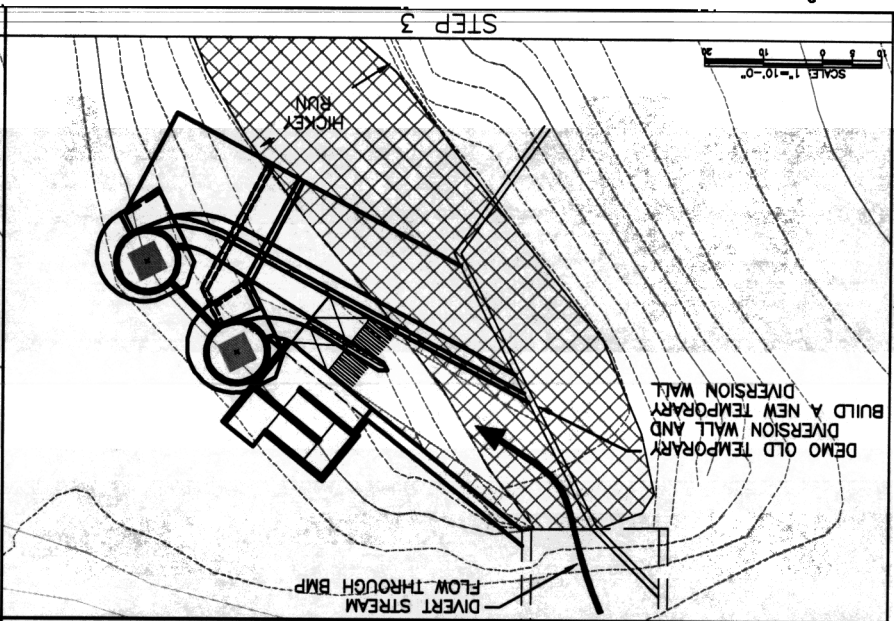

EarthTech

615 S. ALABAMA AVE., SUITE 200
FALLS CHURCH, VA 22044
(703) 261-7800

DCD CDDC NO. 20001
DRAWING NO. 20001
CHECKED BY: J. H. H. (JHH)
DATE: 03/03/03
CONTRACT NO. 162A-77-03-2-1001
SHEET 11 OF 11

NO.	DATE	DESCRIPTION
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9	03/03/03	ISSUED FOR PERMITTING
10	03/03/03	ISSUED FOR PERMITTING

DEPARTMENT OF THE ARMY
NAVY FACILITIES ENGINEERING COMMAND
WASHINGTON, D.C. 20300

PHASE I
HICKEY RUN STORMWATER
POLLUTION ABATEMENT PROJECT
CONSTRUCTION SCHEDULING

NO.	DATE	DESCRIPTION
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